

PROPOSED CHILD CARE CENTRE

Lot 290 (No. 94) Kooyong Road, Rivervale



PLANNING & SURVEY SOLUTIONS



DOCUMENT CONTROL

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City of Belmont RECEIVED 08/10/2019 Application No: 403/2019

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1 INTRODUCTION

This Application to Commence Development (Development Application) has been prepared to formally seek the approval of the City of Belmont to develop a Child Care Centre on Lot 290 (No. 94) Kooyong Road, Rivervale. The proposed development comprises a two storey building with a large outdoor play deck, comprising predominantly of natural construction materials and fixtures. A copy of the Development Plans are included at **Appendix A**.

The Application proposes a Child Care Centre which is designed to accommodate 76 children and 13 staff members. The facility comprises $325m^2$ of creditable internal play space and $542m^2$ of creditable outdoor play space, as well as the associated amenities, offices, landscaping and car parking, sited over two stories.

The proposed development has been designed embracing principles of biophyllic design, acknowledging the positive impacts on wellbeing that natural elements have. The external building facades comprise largely of timber cladding, glazing and timber framed windows. The development comprises timber and glazed fencing, including open and solid format panels, with extensively landscaped play spaces to achieve a predominantly nature based amenity. While not required to be detailed at this stage, it is intended that these play spaces will be fit out with nature-based play equipment in lieu of the more commercial plastic play equipment. The proposed Elevation and Streetscape Perspectives are also included at **Appendix A**.

A review of the City of Belmont's Local Planning Scheme No. 15 and the relevant Local Planning Policies has been conducted in order to prepare this Development Application; which includes a description of the proposed works, the subject land and surrounding locality, planning rationale in support of the application, parking calculations, as well as the various management solutions including landscaping, acoustic treatment and site access.



2 SUBJECT LAND

Lot 290 (No. 94) Kooyong Road, Rivervale ('the subject site') is located on the northern edge of the Rivervale commercial centre (local centre) with frontage to Kooyong Road, Francisco Street and Jupp Lane. The subject site is 814m² in area and currently contains a vacant commercial building and informal parking to the rear of the site. Land to the north-west, north and north-east contains existing medium density development, while land to the south east comprises commercial tenancies including an IGA supermarket, medical centre and a laundromat. **Figure 1** depicts an Aerial Photograph of the Subject Site, and a Feature Survey of the site is included at **Appendix B**.

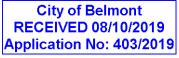


FIGURE 1 – AERIAL PHOTOGRAPH

A summary of the land particulars is provided at **Table 1** and a copy of the Certificate of Title is attached at **Appendix C**.

LOT NO.	PROPERTY ADDRESS	LANDOWNER	VOL.	FOLIO	PLAN NO.
290	94 KOOYONG ROAD, RIVERVALE	TALBANE PTY LTD	1140	790	D16131

TABLE 1 – SUMMARY OF LAND





3 PLANNING FRAMEWORK

3.1 Metropolitan Region Scheme

The subject site, as with the broader surrounding area, is zoned 'Urban' under the Metropolitan Region Scheme (MRS). Orrong Road, located approximately 350m south-west of the subject site, is reserved for 'Other Regional Roads'; which connects with the Graham Farmer Freeway, reserved for 'Primary Regional Roads'.

3.2 City of Belmont Local Planning Scheme No. 15

The land is zoned 'Commercial' under the City of Belmont's Local Planning Scheme No. 15 (LPS 15), consistent with a small strip of 'Commercial' zoned properties fronting Kooyong Road, and one to the rear of the subject site. Land zoned 'Residential' is located to the site's west, north and east in densities ranging from R20 to R40. A small strip of Residential land also exists to the south of the site, fronting Gerring Court. Both Francisco Road and Kooyong Road are zoned 'Arterial Road' under LPS 15. **Figure 2** is an extract of the City's Zoning Map.

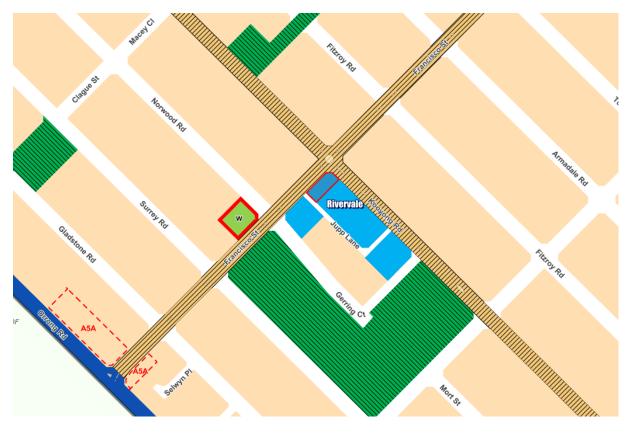


FIGURE 2 – ZONING MAP

The objective of the 'Commercial' zone is defined within Clause 4.5 of the Scheme, as:

"The Town Centre and Commercial Zones are intended to provide for the retail commercial function and entertainment".

The land use definition relevant to this application is defined within Schedule 1 of the Scheme, which is a 'D' use within the 'Commercial Zone'.



"Child Care Premises means premises where -

- a) An education and care service as defined in the Education and Care Services National Law (Western Australia) section 5(1), other than a family day care as defined in that section, is provided; or
- b) A child care service as defined in the Child Care Services Act 2007 section 4 is provided."

The proposed development is a permitted use within the 'Commercial' zone, subject to discretion being applied by the Council, and is entirely consistent with the objective of the zone.

Table 2 of the Scheme sets out the Car Parking Requirements for various uses throughout the municipality. The table prescribes a requirement of "1 space for every employee, plus 1 space per 8 children allowed under maximum occupancy" for Child Day Care Centre uses. This development therefore generates a requirement of 23 car parking spaces (13 staff members and 76 children). The development has proposed 14 bays (including a universal bay), and therefore seeks a variation to the Scheme Requirement. A Transport Impact Statement has been prepared in support of this application and is attached at **Appendix D**.

3.3 Local Planning Policy No. 9 – Child Care Premises and Child Family Day Care

The City of Belmont have prepared Local Planning Policy 9 – Child Care Premises and Child Family Day Care (LPP 9) to provide guidelines to assist in the preparation and assessment of Development Applications for Child Care Centres within the municipality. The objective of LPP 9 is to ensure that:

- Child Care Premises in the City of Belmont are located in areas of compatible land uses and that the needs of the users are adequately served.
- The amenity of landowners adjoining a Child Family Day Care Premises is protected by ensuring adequate development standards and notification.

The proposed application has been developed having regard to LPP 9 where possible, however seeks variations to the following policy criteria:

Locational Criteria

- <u>Clause 5: Sites for Child Care Premises will be required to have a minimum frontage of 20m</u> and a minimum area of 1000m². Lots must be sufficiently large to accommodate the open space/play areas, car parking and other facilities which are necessary.

The subject site is 814m² in area, with a 12.7m frontage to Kooyong Road and secondary street frontage of 38.2m to Francisco Street. Further, the site has rear access to Jupp Lane. The proposed Child Care Centre layout has provided for the required areas per child accommodated of indoor and outdoor play, as set out by the *Child Care Services Act 2007* and the associated Guidelines, as well as the area for access, open space and landscaping. It is considered that the site benefits (rear access and corner location) with the proposed design sufficient accommodate all required functional elements and therefore variation to this criteria is requested.

Development Requirements

- <u>Clause 1: Car parking will be required on site at the standard of one bay per five children and</u> <u>one bay per staff member, plus a paved "put down" and "pick up" area to the satisfaction of</u> <u>Council. Vehicle access to and from the site must be available in forward gear.</u>

The proposed development has been designed having regard to the (differing) car parking standards set out in the City's LPS 15, being 1 bay per 8 children plus 1 bay per staff member. As a result, the parking requirement for this development is 23 car bays. The proposed development provides 14 car spaces including a universal space, with a 1.5m reversing aisle



allowing all vehicles to access the property in forward gear. Further, a Transport Impact Statement has been prepared to assess the impact of the requested parking variation, and is included at **Appendix D**.

- <u>Clause 2: All car parking spaces will be required to be screened from view from the street by</u> <u>a landscaped strip of 2m minimum width. The objective of this requirement is to provide shade</u> <u>and reduce the impact of car parking on the streetscape.</u>

The proposed parking area is located underneath the first floor outdoor play deck, ensuring it is essentially an "under croft" parking area. This parking area is screened from the view of Francisco Street (and partially Jupp Lane) by feature timber fencing, and a strip of landscaping (of 0.8m wide), containing small ornamental trees. This ensures that the car parking area is completely screened from view, though is treated in a material that is sympathetic with the overall development. See Elevations and Streetscape Perspectives at **Appendix A**, and the Concept Landscape Plan at **Appendix E**.

- <u>Clause 4: Buildings for Child Care Premises will be required to be of brick or masonry</u> <u>construction, insulated and have air conditioning. Windows where children congregate within</u> <u>the building should be fixed glazing incapable of being opened.</u>

This development proposes the construction of this child care facility predominantly comprising timber framed modular construction, with the necessary steel supporting columns where necessary. Modular construction reduces the capital input on site, reduces site disturbances and ensures an efficient construction period. The building as proposed is a high quality design, incorporating passive architectural elements to reduce the overall carbon impact and reliance on conventional climate control systems. The proposed design has been reviewed by the potential builders, confirming that it is both compliant with the BCA requirements and able to accommodate all of the required all servicing infrastructure, including energy efficiency considerations.

- <u>Clause 5: Centres should provide a residential appearance so as to maintain a secure and</u> <u>familiar atmosphere for children and be harmonious with the character of the streetscape.</u>

This development has been designed having regard to biophyllic design and the wellbeing benefits of natural elements, passive energy principles and the existing streetscape of the locality. As such, it has been designed to reflect these elements; particularly given the subject site's corner location, it also seeks to provide for a notable and highly identifiable development.

It is further considered that this criteria was not intended to be applied to development with Commercial zoned areas; and while there is residential land surrounding, it is not considered that the existing amenity of this local centre is consistent with this residential theme. This facility has been designed to promote early childhood learning, rather than simply care, and has therefore provided spaces conducive to that.

The proposal has been designed having regard to the City's Local Planning Policy No. 9 where possible, as well as the detailed requirements set out in the *Child Care Services Act 2007* and its associated Guidelines. Its design seeks variations, as outlined above, to optimise its passive energy opportunities, provide contemporary spaces for children to promote early childhood learning and achieve a high quality natural amenity within the facility. It is therefore considered that despite the minor variations to the policy criteria, the design as presented meets the objective of Local Planning Policy No. 9.



4 PROPOSED DEVELOPMENT

4.1 Development Summary

The proposed development has been designed having regard to the City's LPP 9, the surrounding streetscape and locality, as well as the site's benefits and constraints. The approval of this development will facilitate the construction of a new child care centre facility, which intends to accommodate a maximum of 76 children and 13 staff members.

The development has been designed to ensure the following:

- A robust architectural statement is sited on the corner of Francisco Street and Kooyong Road, being a prominent landholding in the area;
- The car parking area is screened from public view, and accessible via the rear laneway;
- The retention of a mature Jacaranda tree, with it being 'built into' the facility.

Furthermore, the proposed child care facility utilises passive architectural design to promote a nature based education theme throughout the site. Internally, the age-specific indoor play spaces are separated by low-level walls, provided to increase solar access, natural ventilation and to ensure an open-plan style of play space.

The outdoor play areas are sited over two stories; however a large majority of the outdoor play area is on the first floor on a large, open air deck space. This outdoor play spaces are intended to accommodate a wide range of outdoor play activities. The Concept Landscaping Plan has been prepared to illustrate the intended landscaping treatments of the development; particularly on the first floor deck. Overall, the development strives to promote and replicate natural elements and design, and enhance nature based sensory learning.

4.2 Site Layout & Design

The proposed improvements to the site are demonstrated in the attached Development Plan Set, including a Development Site Plan, Floor Plans, Elevations and Streetscape Perspectives (**Appendix A**). The proposed development includes the construction of a 76 place child care centre, with play spaces sited over two floors. The site has been designed to maximise the solar access to both internal and external play spaces.

The entrance to the facility is located on the corner of the Francisco Street-Kooyong Road intersection. It provides direct access from the existing pedestrian network to a reception area. The internal play areas, and associated junior amenities, are also located on the ground floor, with access to a small, grassed outdoor play space.

The first floor includes the internal play spaces for older children (above 24 months) in a large, open format design, as well as their associated amenities. The internal play spaces provide direct access to the large, open deck outdoor play space of 420m² in area.

Signage for any part of the development is not proposed and will be subject to a separate application.

4.3 Building Design & Rationale

The proposed development has been designed in a manner which intends to emphasise and promote natural elements and nature based play, while still respecting its urban context. The development utilises passive design elements ensuring that, where possible, the design is able to provide sufficient solar access and natural ventilation.



The external façade comprises predominantly of timber cladding, with feature window frames and awnings for internal weather protection. It is intended that the proposed child care centre building will provide for a strong corner presence on the Kooyong Road-Francisco Street intersection, while still providing for a high level of activity and surveillance throughout due to the active nature of the land use.

Other rationale for the building design is as follows:

- The natural elements of the building design have been chosen in response to the positive impacts on wellbeing and air quality as a result of incorporating biophylic design; in this case, by incorporating natural construction elements, placement of building openings and the nature passed play equipment throughout the site.
- The architectural design intends to provide visual interest to the street, taking advantage of its location on a prominent corner of an area which would benefit from some regeneration. The development seeks to bring a natural presence to the locality, which is largely built up currently.
- This application proposes the use of modular buildings, which will reduce the reliance on traditional methods of construction including concrete and steel framework. Modular construction will also provide for a shorter construction time, and therefore reduced cost of development.
- It is anticipated that a child care centre will be a much sought after land use within this largely residential area; particularly considering the density increase which is occurring due to the areas split coding. This centre will therefore be able to service the needs of this population from within the locality.
- The buildings have been designed to optimise natural cross ventilation with the incorporation of operable highlight windows and open plan play spaces.
- The buildings have been sited to optimise natural breezes and solar access during all times of the year, reducing the development's reliance on conventional climate control systems.
- The Concept Landscaping Plan features a range of deciduous tree species to ensure natural shading during the summer months and solar access during the winter months.
- The development utilises awnings, highlight windows and double glazed windows to ensure the optimised natural lighting and ensuring the building retains a comfortable internal temperature.
- The proposed roof has been to allow any future landowner or tenant the option to install solar collectors for energy harvesting.

4.4 Hours of Operation & Staffing

The Child Care Centre will operate from 6.00am to 6.30pm on weekdays only (Monday to Friday). The facility has been designed to accommodate a maximum of 76 children at any one time. In accordance with the *Child Care Services Act 2007* and the associated Guidelines, it is anticipated that a total of 13 staff members would be employed to manage the centre at full capacity at any one time.

4.5 Landscaping

A Concept Landscaping Plan has been included at **Appendix E** which demonstrates the provision of significant landscaping where possible throughout the development. The Concept Landscape Plan illustrates the location and species throughout the site, largely located on the first floor play deck.



The plan contemplates fruiting trees, vines and includes a vegetable garden to enhance the nature based play aspect of the facility.

It is anticipated that a detailed landscaping and reticulation plan will be required as a condition of approval, to the satisfaction of the City of Belmont.

4.6 Car Parking & Access

The development will be accessed via a new 6m wide crossover to Jupp Lane. This crossover will provide direct access to the car parking area, which accommodates parking spaces for 14 vehicles (including 1 universal access space). The parking area provides pedestrian access to the facility entrance via the Francisco Street pedestrian network.

Table 2 of Local Planning Scheme No. 15 provides the parking requirements for various land uses within the City. **Table 2**, below, demonstrates this car parking requirement and provides the calculated requirement applicable to this development, being 23 bays, and thus, a 9 bay parking shortfall is proposed.

PROPOSED USE	CAR PARKING REQUIREMENT	PROPOSED CAPACITY	REQUIRED BAYS
Child Care Centre	ild Care Centre 1 : 1 employee, plus 1 : 8 children		22.5 bays

TABLE 2 – CAR PARKING CALCULATIONS

The attached TIS (**Appendix D**) concludes that the proposed parking area will adequately accommodate the parking demand generated by the facility for the following reasons:

- There is a generous amount of existing street parking within both the Francisco Street and Kooyong Road, which is more likely to be used by parents for short term stays, given the ease of accessibility.
- Visitors to the site are generally concentrated between 7.00am 9.00am (morning peak) and
 2.30pm 6.30pm (afternoon peak), and generally only stay for between 2 and 10 minutes.
- Additional public parking exists at the adjacent Rivervale Community Centre and Gerring Street; however it is unlikely this will be required.
- A Transperth bus stop is located approximately 100m south-east of the subject site, which is serviced by the 935 high frequency route, providing direct connections to the Perth CBD, Burswood, Belmont Forum and the Perth Airport.
- The development is located in an area with existing high quality pedestrian and cycling paths. The development further seeks to promote active transport modes by including bicycle racks, personal lockers and change and shower facilities.



5 TOWN PLANNING CONSIDERATIONS

5.1 Acoustic Management

An Environmental Acoustic Assessment (EAA) has been prepared in support of the proposed development, and is attached at **Appendix F**. The EAA was prepared by Herring Storer to assess and address the outgoing noise emissions from the Child Care Centre and provides management solutions to ensure the development is able to comply with the *Environmental Protection (Noise) Regulations 1997*, thereby ensuring the existing amenity of the neighbouring residents is maintained.

The EAA considers the likely noise sources occurring within this development as being car doors closing, the building's mechanical services and children playing in outdoor play areas. In order to achieve compliance with the Regulations at all times, the development would be required to adhere to the following recommendations:

- No use of the outdoor play areas prior to 7.00am;
- First floor deck (north western side fence) is to be solid to a height of 1.2m; and
- Mechanical services are located within the plant rooms, or otherwise assessed by a suitably qualified consultant.

5.2 Stormwater Drainage

It is anticipated that a Drainage Management Plan shall be required as a condition of approval, to the satisfaction of the City of Belmont, prior to the issuing of a Building Permit. In any case, it is expected that all stormwater runoff will be able to be contained within the site via soak wells, detention cells and within the areas of landscaping; and that no stormwater runoff will be discharged off site.

5.3 Waste Management

A 13m² bin store area has been provided within the facility's parking area, designed to store a maximum of 8 bins. The bin store is proposed to be lockable, and treated with the same fencing as utilised throughout the entire development. It is anticipated that the development will utilise the City's waste management services, with collection occurring from either Jupp Lane or Francisco Street, as required by the City. Alternatively, a private contractor is able to be accommodated by this development layout if required.




6 CONCLUSION

This Development Application has provided the relevant details and supporting rationale for the development of a Child Care Centre at Lot 290 (No. 94) Kooyong Road, Rivervale. This proposal would allow for the development of a Child Care Centre facility which could accommodate a maximum of 76 children and 13 members of staff.

This submission demonstrates that the servicing and management requirements for the facility, including acoustic, waste and stormwater management can be adequately met. This submission has also demonstrated that the proposal is compliant with the intent of and each of the policy parameters of the City's Local Planning Policy 9, as well as the Local Planning Scheme 15 and the relevant planning framework.

The proposal, and in particular, it's unique and passive architectural form, intends to service and improve the overall amenity of the area, by affording greater opportunities for landscaping within the locality and increasing the area's tree canopy. It is anticipated that a Child Care Centre facility will be a much sought after services, particularly given the steady residential growth in the area afforded by the blanket split residential coding in the area. It is considered that this development will be a positive contribution to the overall area, increasing the level of activity and vibrancy to this local centre.

In view of the attributes of this proposal, as provided within this report, the associated Development Plans and supporting technical studies, it is respectfully requested that the City of Belmont approve this child care centre as presented on Lot 290 Kooyong Road, Rivervale. Should you have any further queries, please do not hesitate to contact Madison Mackenzie at this office.

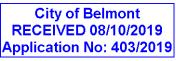

APPENDIX E | CONCEPT LANDSCAPING PLAN



FEATURE TIMBER FENCING AROUND PERIMETER OF SITE/OUTDOOR PLAY DECK



JASMINE TO BE PLANTED W/WIRE TO ALLOW CREEPING



SENSORY PATH (WOOD CHIPS/TIMBER LOGS/SAND/STONE)



SOFTFALL ALONG UPPER DECK



TREE TRUNK/LOGS IN SANPIT TO FORM NATURAL CLIMBING STRUCTURE



CLIMBING STRUCTURE/SLIDE INTO SANDPIT



TIMBER BENCH TO BE BUILT AROUND EXISTING TREE/VOID ON UPPER DECK




CHILDREN'S TEEPEE ON UPPER DECK



TIMBER 'WALKWAY'



FRUIT TREES TO BE PLANTED IN LARGE POTS ON UPPER PLAY DECK

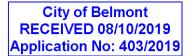



STUDIO 25 | ARCHITECTURAL DRAFTING

CAMBRIDGE STREET WEST LEEDERVILLE PERTH, WA 6007

T. 0450 253 643

94 KOOYONG ROAD

LANDSCAPING LEGEND

Project number	250037	_
Date	08/10/2019	A106
Drawn by	VD	
Revision	А	Scale



DWARF MONDO OPHIOPOGON JAPONICUS NANA 100MM (H) X 100-150MM (W)













TRIXZIE PEAR MINI FRUIT TREE PYRUS COMMUNIS 1.5M (H) X 1.5M (W)



DWARF LEMON MEYER CITRUS X LIMON 1.5M (H) X 1.5M (W)



DWARF VALENCIA ORANGE CITRUS SINENSIS 1.5M (H) X 1.5M (W)



DWARF NECTARINE NECTA RED PRUNUS PERSICA 2M (H) X 2M (W)

FIRST FLOOR LANDSCAPING PLAN					
Project number	250037				
Date	07/10/2019	Ι Α	108		
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DEVELOPMENT SUMMARY


TOTAL SITE AREA:	814m ²
TOTAL GF BUILDING FOOTPRINT	218m ²
RECEPTION/FOYER/CORRIDOR:	41m ²
LAUNDRY:	7m ²
STAFF ROOM:	12m ²
OFFICE:	12m ²
0-18 MONTHS:	31m ²
18-24 MONTHS:	34m ²
BABY CHANGE:	16m ²
COT ROOM:	9m ²
BOTTLE PREP:	7m ²
UAT:	6m ²
STORE 1:	2m ²
STORE 2:	5m ²
GF OUTDOOR PLAY AREA	122m²
TIMBER DECK:	122m²
CAR PARK AREA	474m²
BITUMECAR PARK	384m²
LANDSCAPING	72m²
PAVING	18m²
TOTAL FF BUILDING FOOTPRINT	310m ²
LANDING(INC LIFT/STAIR):	25m ²
KITCHEN	14m ²
STAFF WC:	3m ²
STORE:	8m ²
24-36 MONTHS:	112m ² (+4m ² REDUN.)
+36 MONTHS:	107m ²
JUNIOR WC:	13m ²
FF OUTDOOR PLAY DECK	420m ²
TOTAL ROOF BUILDING FOOTPRINT	<u>305m²</u>





CHILD CARE SUMMARY

TOTAL:	76 CHILDREN	247m ² /532m ²	284m ² /542m ²
+36 MONTHS	30 CHILDREN	97.5m ² /210m ²	107m ² /420m ² comb. FF
24-36 MONTHS	30 CHILDREN	97.5m ² /210m ²	112m ² /420m ² comb. FF
18-24 MONTHS	8 CHILDREN	26m ² /56m ²	65m ² /122m ² comb. GF
0-18 MONTHS	8 CHILDREN	26m ² /56m ²	65m ² /122m ² comb. GF
AGE GROUPS	NO. OF CHILDREN	REQ. AREA	PROV. AREA

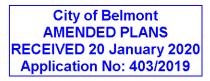

PLEASE NOTE: ALL MECHANICAL COMPONENTS TO COMPLY WITH ALL RELEVANT NOISE REGULATIONS. FURTHER DETAIL TO BE PROVIDED AT BUILDING DOC STAGE.


FRANCISCO STREET

112m²/420m² comb. FF

107m²/420m² comb. FF

284m²/542m²



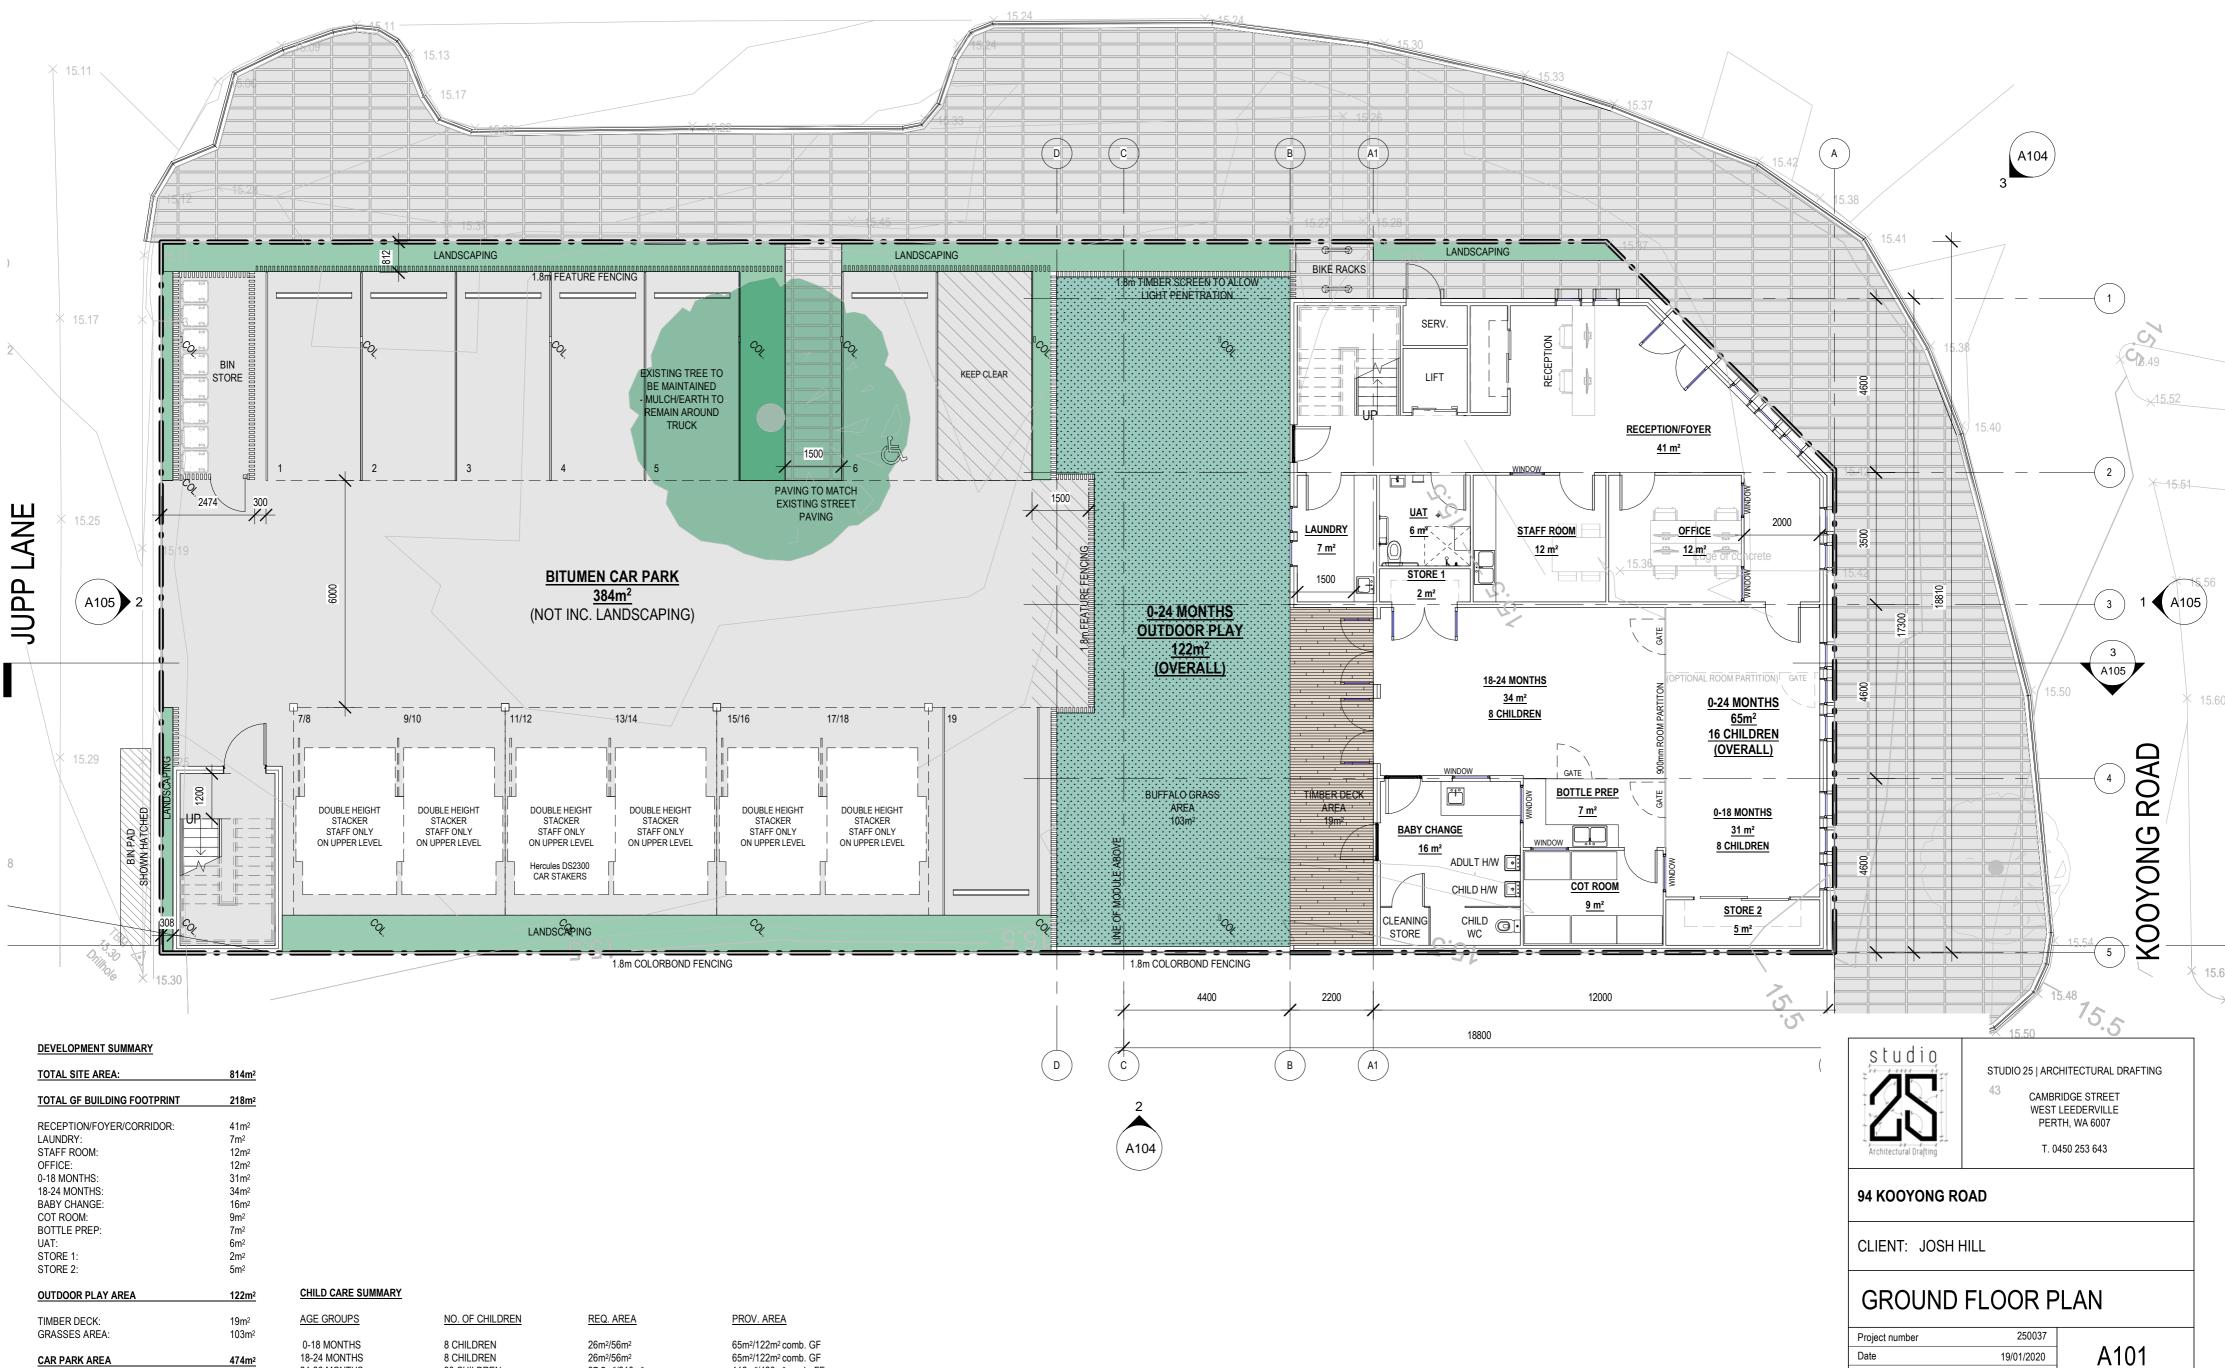

TOTAL SITE AREA:	814m ²			
TOTAL GF BUILDING FOOTPRINT	218m ²			
RECEPTION/FOYER/CORRIDOR:	41m ²			
LAUNDRY:	7m ²			
STAFF ROOM:	12m ²			
OFFICE:	12m ²			
0-18 MONTHS:	31m ²			
18-24 MONTHS:	34m ²			
BABY CHANGE:	16m ²			
COT ROOM:	9m ²			
BOTTLE PREP:	7m ²			
UAT:	6m ²			
STORE 1:	2m ²			
STORE 2:	5m ²			
OUTDOOR PLAY AREA	122m ²	CHILD CARE SUMMARY		
TIMBER DECK:	19m ²	AGE GROUPS	NO. OF CHILDREN	REQ. AREA
GRASSES AREA:	103m ²			
		0-18 MONTHS	8 CHILDREN	26m ² /56m ²
CAR PARK AREA	474m ²	18-24 MONTHS	8 CHILDREN	26m ² /56m ²
BITUMECAR PARK	384m ²	24-36 MONTHS	30 CHILDREN	97.5m ² /210m ²
		+36 MONTHS	30 CHILDREN	97.5m ² /210m ²
LANDSCAPING	72m ²			
PAVING	18m ²	TOTAL:	76 CHILDREN	247m ² /532m ²






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A Scale


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Revision




TOTAL SITE AREA:	814m ²				
TOTAL FF BUILDING FOOTPRINT	<u>314m²</u>				
LANDING(INC LIFT/STAIR): KITCHEN	25m ² 18m ²	CHILD CARE SUMMARY			
STAFF WC: STORE:	3m ² 8m ²	AGE GROUPS	NO. OF CHILDREN	REQ. AREA	PROV. AREA
24-36 MONTHS: +36 MONTHS: JUNIOR WC:	112m² (+4m² REDUN.) 107m² 13m²	0-18 MONTHS 18-24 MONTHS 24-36 MONTHS +36 MONTHS	8 CHILDREN 8 CHILDREN 30 CHILDREN 30 CHILDREN	26m²/56m² 26m²/56m² 97.5m²/210m² 97.5m²/210m²	65m ² /122m ² comb. GF 65m ² /122m ² comb. GF 112m ² /420m ² comb. FF 107m ² /420m ² comb. FF
OUTDOOR PLAY DECK	420m ²	TOTAL:	76 CHILDREN	247m ² /532m ²	284m²/542m²



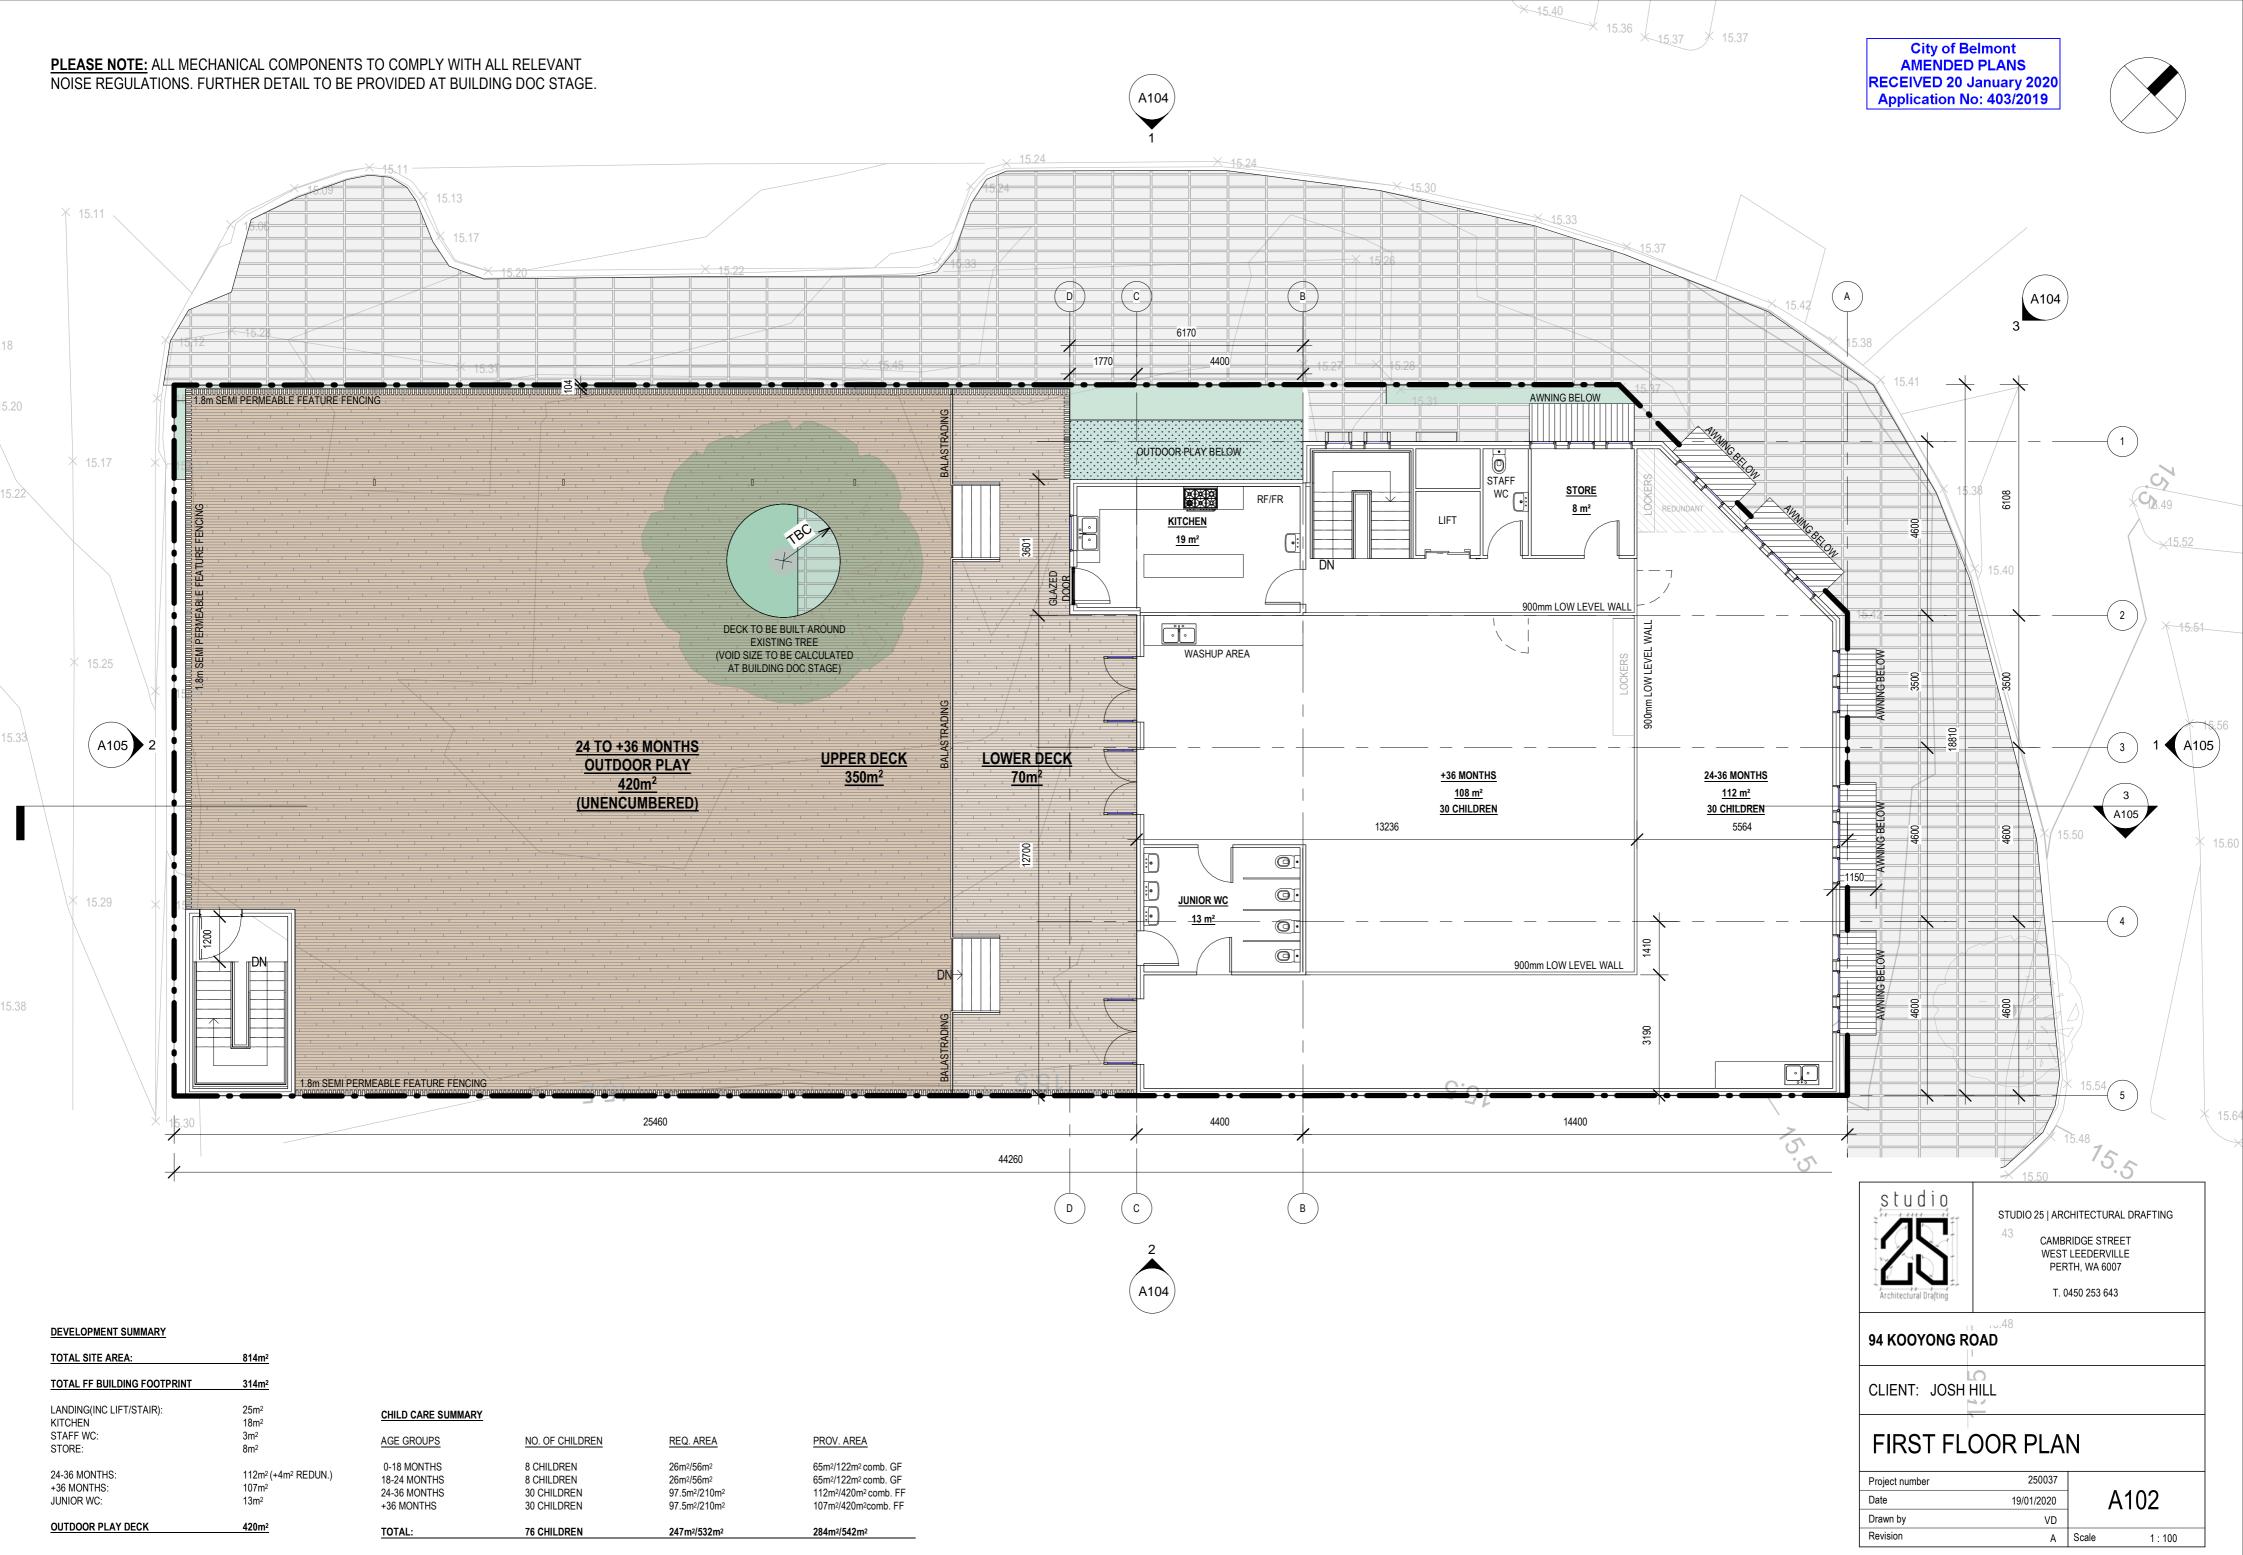

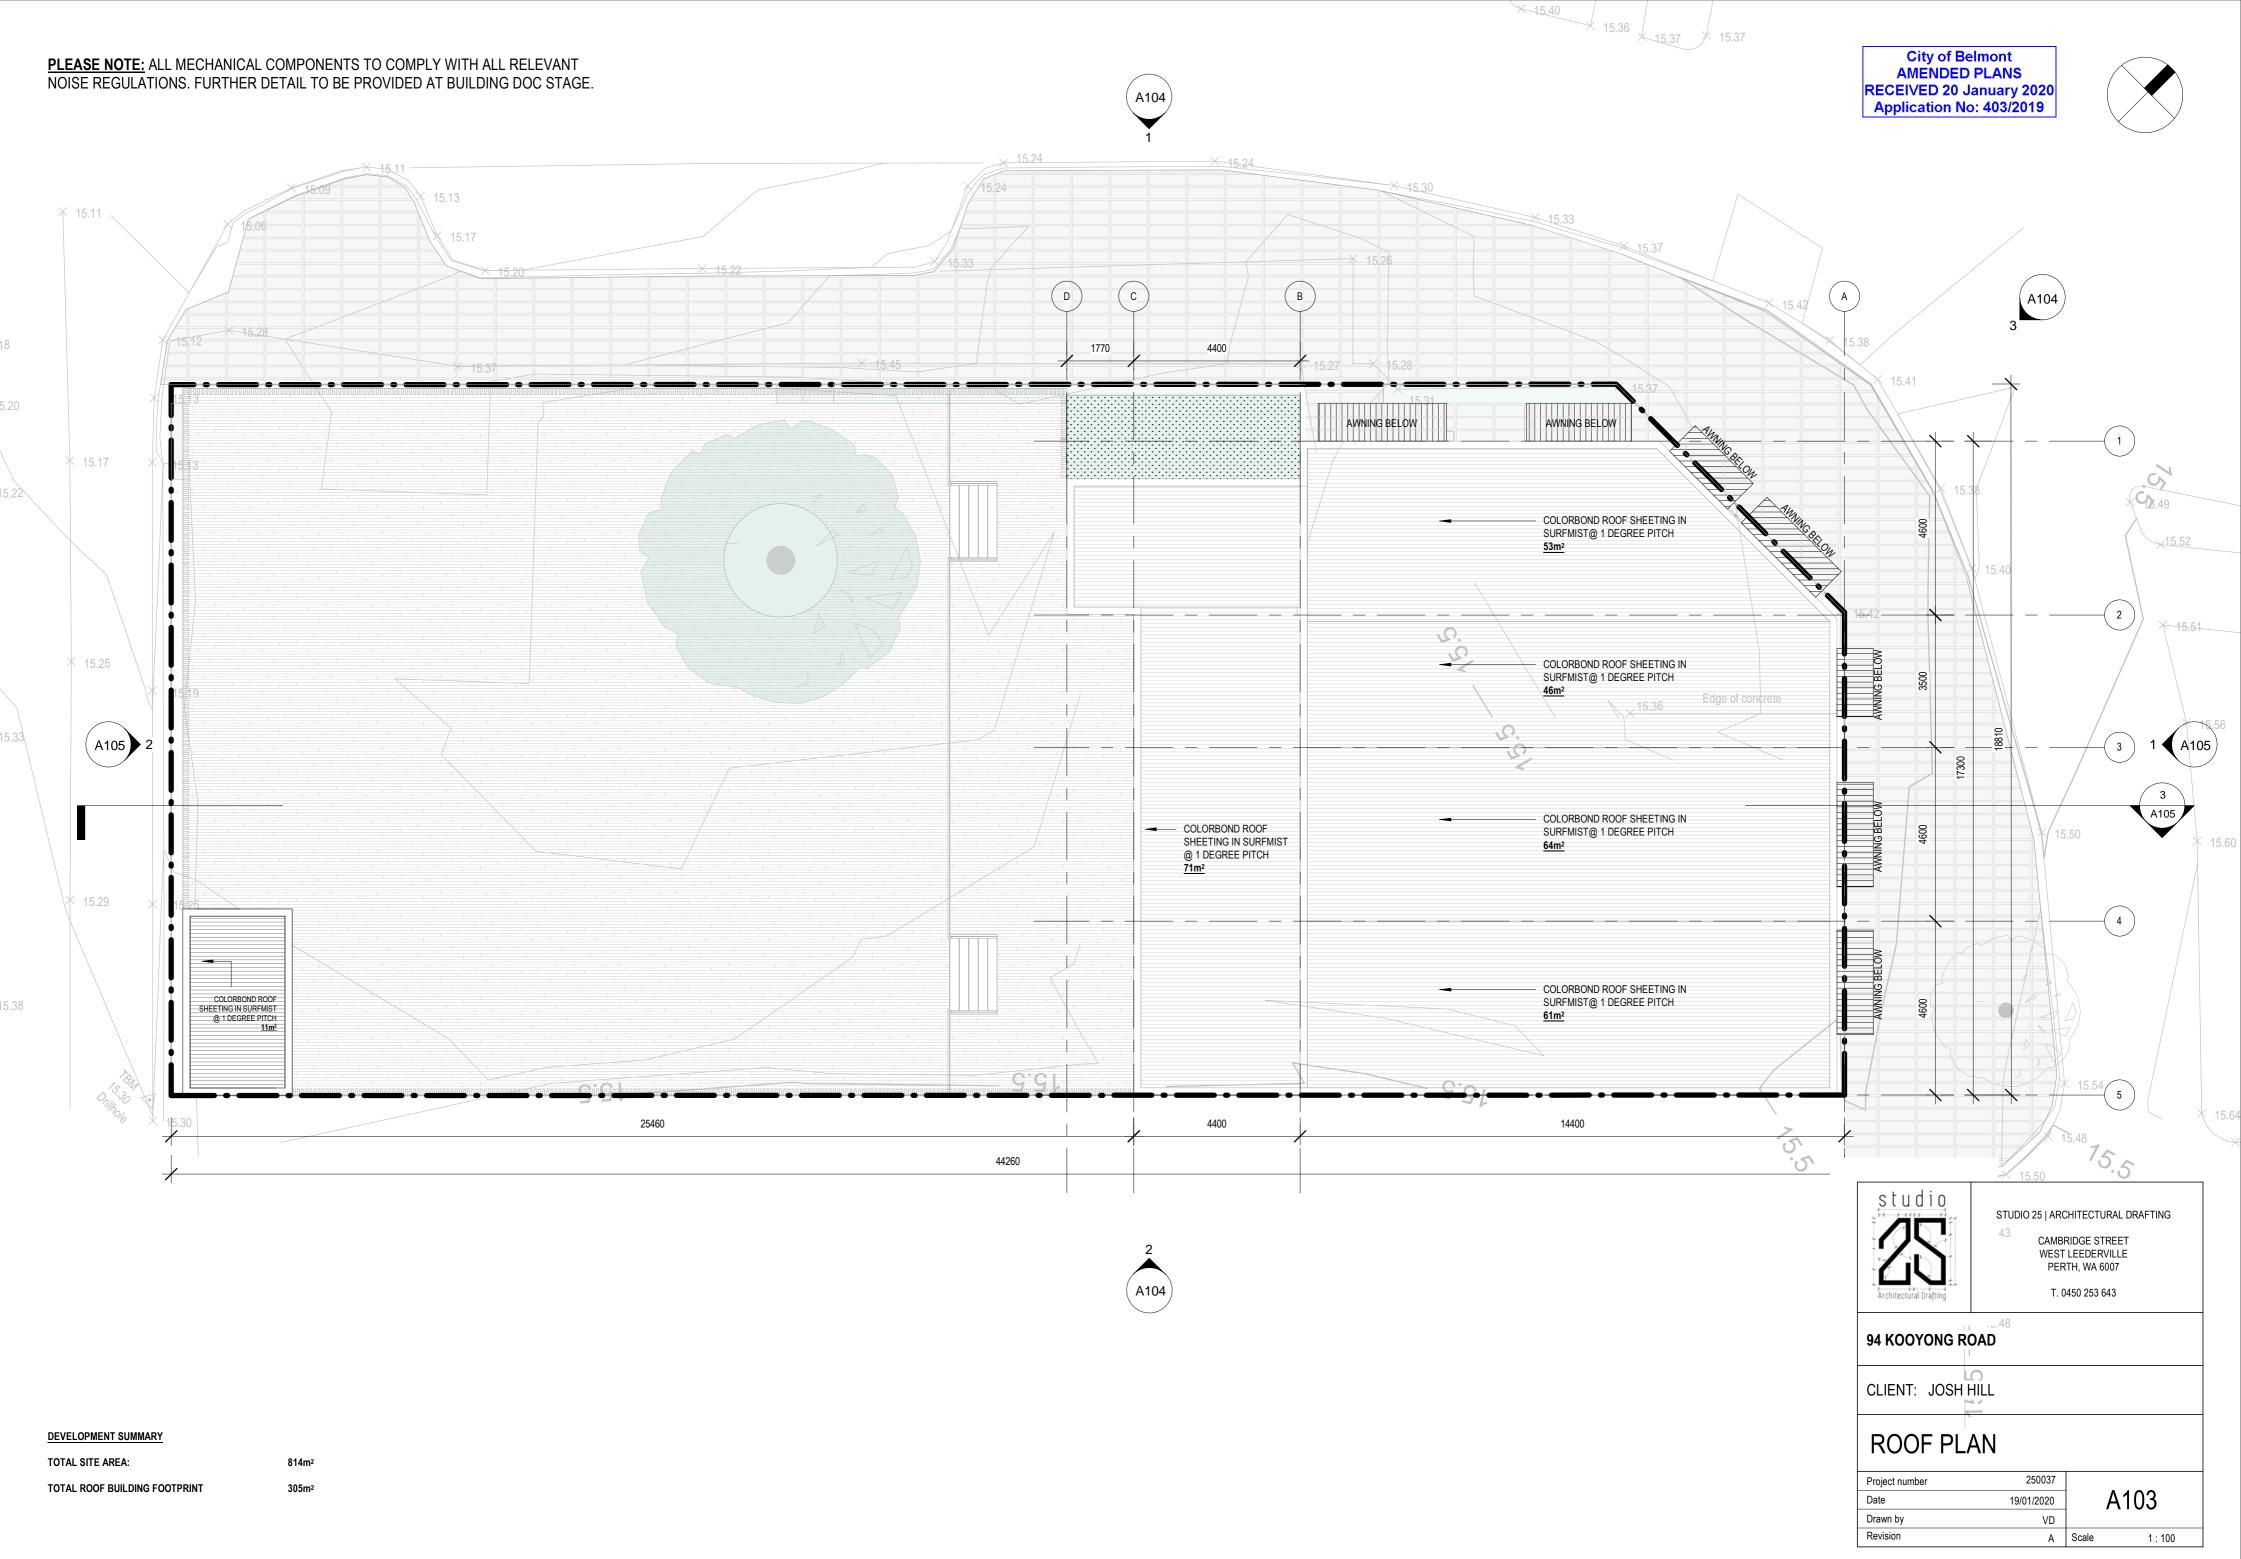TOTAL SITE AREA:	814
TOTAL ROOF BUILDING FOO	OTPRINT 30




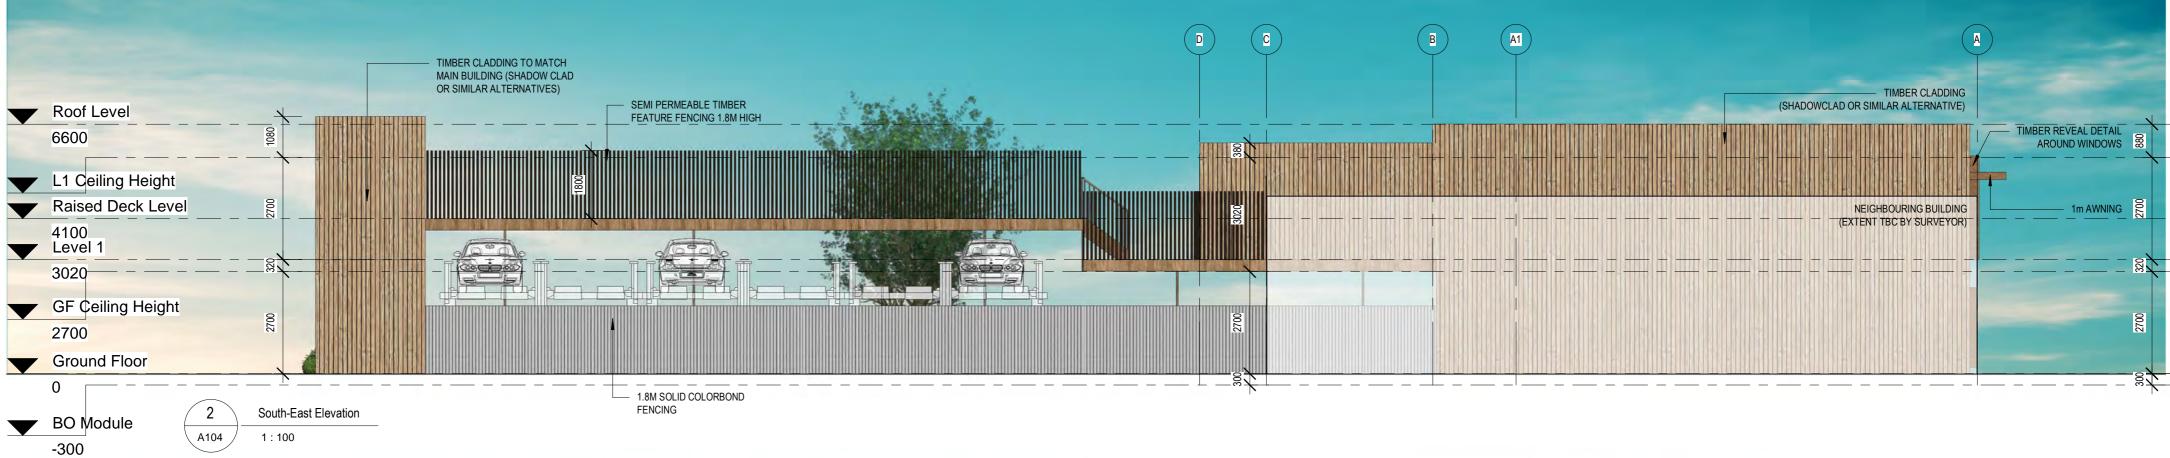







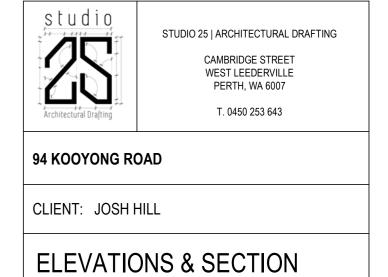

Project number	250037					
Date	19/01/2020	1 A	A105			
Drawn by	VD					
Revision	А	Scale	1 : 100			

City of Belmont
AMENDED PLANS
RECEIVED 20 January 2020
Application No: 403/2019



FEATURE TIMBER FENCING AROUND PERIMETER OF SITE/OUTDOOR PLAY DECK



JASMINE TO BE PLANTED W/WIRE TO ALLOW CREEPING



TREE TRUNK/LOGS IN SANPIT TO FORM NATURAL CLIMBING STRUCTURE



CLIMBING STRUCTURE/SLIDE INTO SANDPIT



TIMBER BENCH TO BE BUILT AROUND EXISTING TREE/VOID ON UPPER DECK



CHILDREN'S TEEPEE ON UPPER DECK



SHADE SAIL ON UPPER DECK



FRUIT TREES TO BE PLANTED IN LARGE POTS ON UPPER PLAY DECK



STUDIO 25 | ARCHITECTURAL DRAFTING

CAMBRIDGE STREET WEST LEEDERVILLE PERTH, WA 6007

T. 0450 253 643


94 KOOYONG ROAD

CLIENT: JOSH HILL

LANDSCAPING LEGEND

City of Belmont AMENDED PLANS RECEIVED 20 January 2020 Application No: 403/2019

Project number250037Date19/01/2020Drawn byVDRevisionBScale

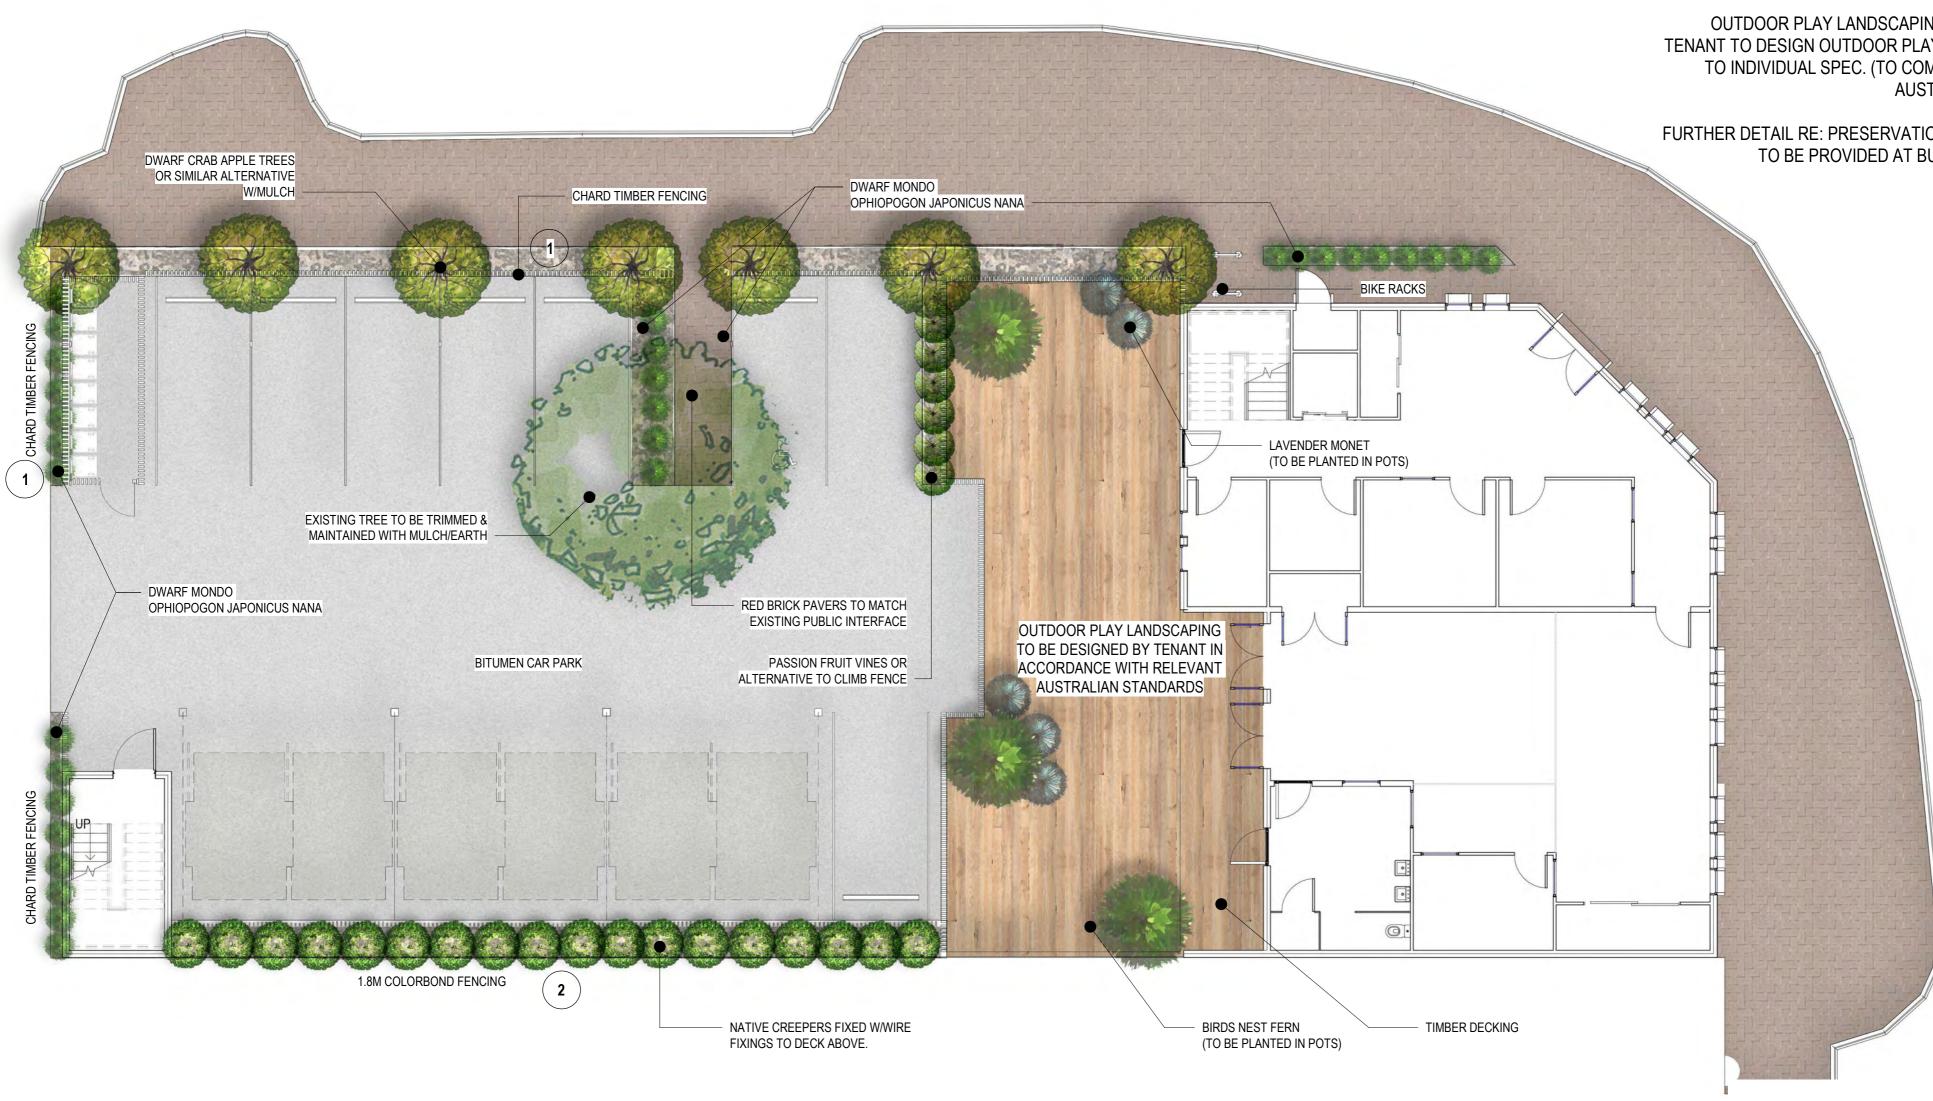



DWARF MONDO OPHIOPOGON JAPONICUS NANA 100MM (H) X 100-150MM (W)



CHINESE STAR JASMINE TRACHLEOSPERMUM JASMINOIDES 4M (H) X 2M-3M (W)



DWARF CRAB APPLE MALUS TORINGO 'AROS' 2-3M (H) X 2.4M (W)



PASSION FRUIT PASSIFLORA EDULIS 4.5M (H) X 2.4-4.5M (W)



BIRDS NEST FERN ASPLENIUM AUSTRALASICUM 1.5M (H) X 3M (W)

PLEASE NOTE:

OUTDOOR PLAY LANDSCAPING IS CONCEPT ONLY. TENANT TO DESIGN OUTDOOR PLAY AREAS ACCORDING TO INDIVIDUAL SPEC. (TO COMPLY WITH RELEVANT AUSTRALIAN STANDARDS)

FURTHER DETAIL RE: PRESERVATION OF EXISTING TREE TO BE PROVIDED AT BUDILDING DOC STAGE



LAVENDER MONET LAVANDULA DENTATA 1M (H) X 1M (W)

*PLEASE NOTE: ALL PLANTINGS WITHIN GROUND FLOOR OUTDOOR PLAY TO BE PLANTED IN POTS

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STUDIO 25 | ARCHITECTURAL DRAFTING

CONCEPT ONL


CAMBRIDGE STREET WEST LEEDERVILLE PERTH, WA 6007 T. 0450 253 643

94 KOOYONG ROAD

CLIENT: JOSH HILL

GF LANDSCAPING

Project number 250037 A107 Date 19/01/2020 Drawn by VD Revision B Scale 1:10

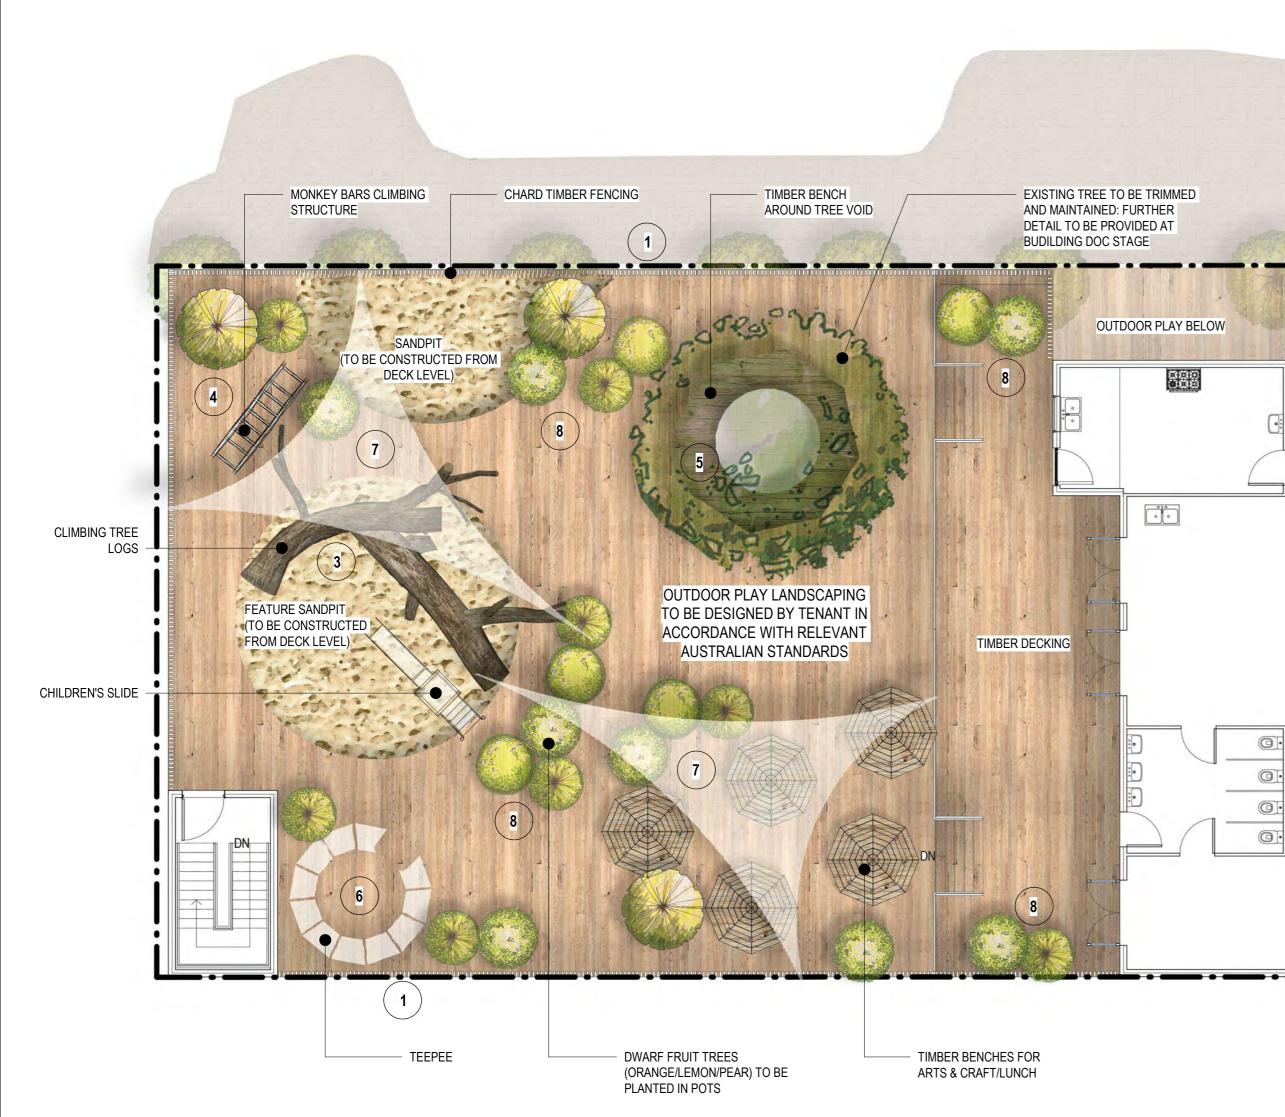



TRIXZIE PEAR MINI FRUIT TREE PYRUS COMMUNIS 1.5M (H) X 1.5M (W)



DWARF LEMON MEYER CITRUS X LIMON 1.5M (H) X 1.5M (W)



DWARF VALENCIA ORANGE CITRUS SINENSIS 1.5M (H) X 1.5M (W)



DWARF NECTARINE NECTA RED PRUNUS PERSICA 2M (H) X 2M (W)

PLEASE NOTE:

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FURTHER DETAIL RE: PRESERVATION OF EXISTING TREE TO BE PROVIDED AT BUDILDING DOC STAGE

studio Architectural Drafting

STUDIO 25 | ARCHITECTURAL DRAFTING

CONCEPT ONLY

CAMBRIDGE STREET WEST LEEDERVILLE PERTH, WA 6007

T. 0450 253 643

94 KOOYONG ROAD

CLIENT: JOSH HILL


FF LANDSCAPING PLAN

Project number250037Date19/01/2020Drawn byVDRevisionBScale1 : 10

City of Belmont AMENDED PLANS RECEIVED 20 January 2020 Application No: 403/2019

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N							
GTH	5,000 mm						
DTH	2, 4 00 mm						
GHT	2,050 mm						
GHT	2,300 kg						
2.2 kW							
55 sec							
5V imes 50HZ imes 3P							
$0V \times 50HZ \times 1P$							

City of Belmont AMENDED PLANS RECEIVED 17 January 2020 Application No: 403/2019

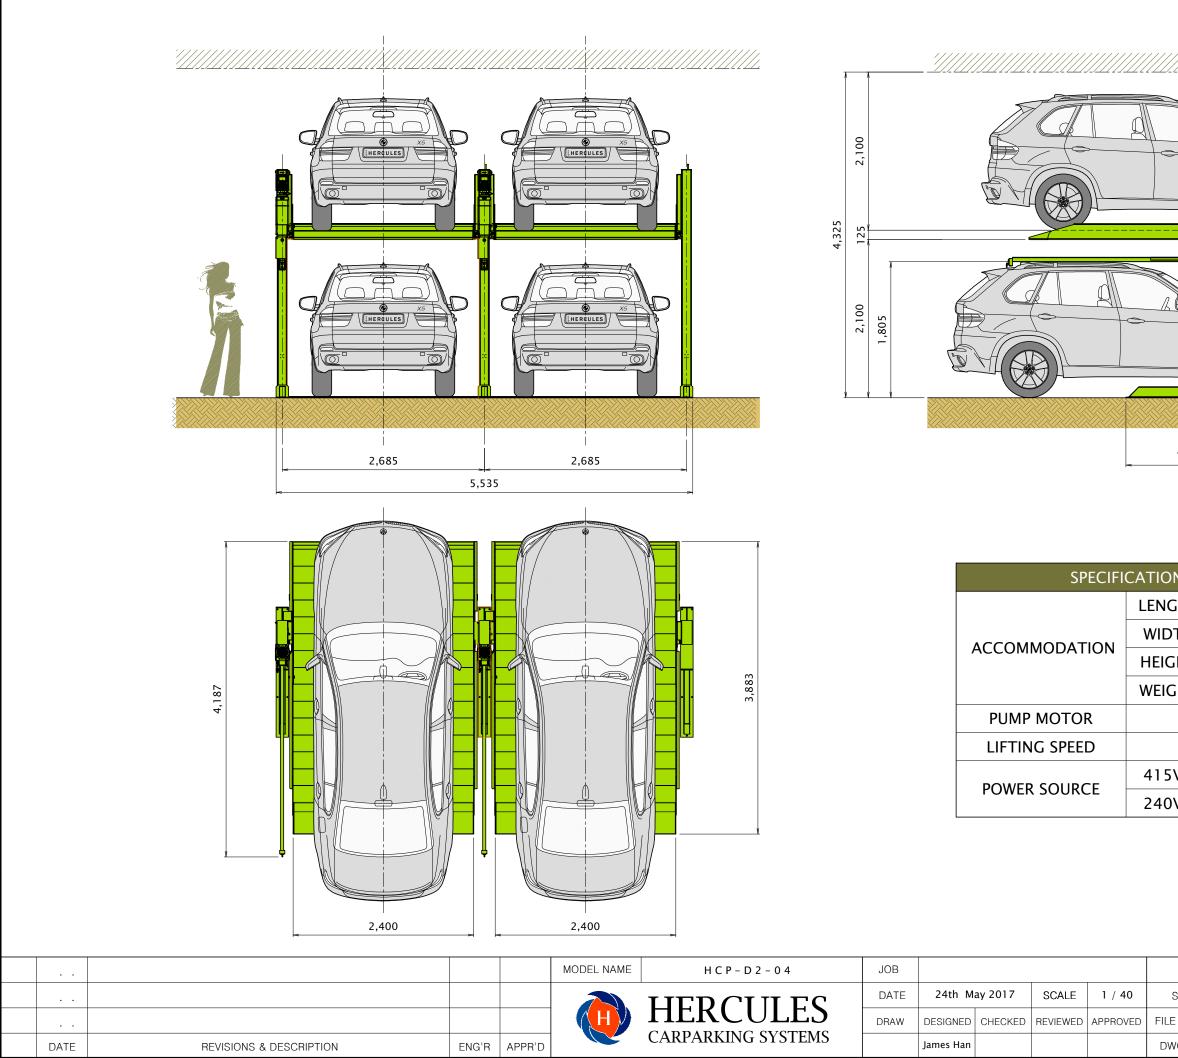TITLE			$2 \times \text{DOUBLE STACKER}$										
SUBJECT	-	LAYOUT											
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DWG NO.	Н	С	Ρ		D	S	2	_	0	0	2	HEV.	\square